

GENERAL NOTES FOR BUILDING:

GENERAL NOTES:


- 1. BUILDING PACKAGE CONFORMS TO: - NATIONAL BUILDING CODE 2023-ALBERTA EDITION
- 2. GROUP F DIVISION 3 OCCUPANCY CATEGORY AS PER NATIONAL BUILDING CODE CANADA 2020, TABLE 3.1.2.1

BUILDING IMPORTANCE CATEGORY - NORMAL

BUILDING COMPONENTS:

EXTERIOR WALL AND ROOF PANELS: 22GA PREPAINTED GALVALUME PANELS CONFORMING TO ASTM A792-09, WITH COATING CONFORMING TO AZ50.

SELF-FRAMING PANEL DIMENSIONS:

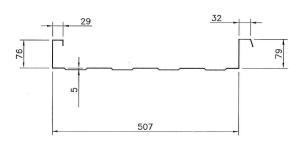

BUILDING NOTES:

- MULTI OIL WELL BATTERY BUILDING SHALL BE A GABLE STYLE SELF-FRAMING BUILDING, ERECTED ON A STEEL SKID IN OUR
- 2. WALL TO CONSIST OF:
 - 22GA SELF-FRAMING WALL PANELS;
 - R12 (76mm) MINERAL WOOL INSULATION;
 - CONTINUOUS 6MIL CERTIFIED POLY VAPOR BARRIER;
 - 24GA WHITE FLUTED ALUMINUM LINER.
- ROOF TO CONSIST OF:
 - 22GA SELF-FRAMING ROOF PANELS;
 - 24GA INSULATION CLIPS 9" DEEP 24GA:
 - R20 (152mm) MINERAL WOOL INSULATION;
 - CONTINUOUS 6MIL CERTIFIED POLY VAPOR BARRIER;
 - 24GA WHITE FLUTED ALUMINUM
- 1 @ FULL LENGTH ANGLE ICE RAKES
- 1 @ FULL LENGTH EAVES TROUGH C/W GUTTER, DOWNSPOUT AND ELBOW.
- 1 @ 16GA 1829mm W x 2,134mm H R4 INSULATED HOLLOW CORE DOUBLE DOOR C/W:
 - 16GA DOUBLE DOOR FRAME;
 - HYDRAULIC CLOSER; Removed
 - CHECK CHAIN;
 - TWO (2) 610mm W x 610mm H IWG WINDOWS;
 - BARRÈL BOLTS;
 - DOREX PANIC HARDWARE:
 - WEATHER STRIPPING;
 - SWEEPS;
 - THRESHOLD;

O 06 MAY/25 ISSUED FOR APPROVAL
OA 23 JUN/25 RE-ISSUED FOR APPROVAL

- 16GA DOUBLE DOOR CANOPY W/ TWO (2) 16GA VERTICAL SUPPORT CHANNELS.

MO JV MF AG JV MF

- 7. 1 @ 1087mm W x 500mm H ACCESS DOOR
- 8. HVAC

(REFER TO DATA SHEETS FOR FULL SPECS; ANY DISCREPANCY BETWEEN THESE DRAWINGS AND DATA SHEETS, THE DATA SHEETS SHALL BE ASSUMED CORRECT)

- 2 @ 12"W x 12"H MANUALLY OPERABLE LOUVER C/W:
- FLANGE FRAME;
- MANUAL WING NUT CONTROLLER:
- BIRD SCREEN;
- 22GA STORM HOOD

1 @ 12" EXPLOSION PROOF EXHAUST FAN (120V/1PH/60HZ) C/W:

- SHUTTER;
- BACK GUARD;
- BIRD SCREEN:
- 22GA STORM HOOD.
- 1 @ SUPPLY ONLY CATADYNE WX24x30 CATALYTIC HEATER C/W:

Removed

- 20,000 BTUH:
- NATURAL GAS CONFIG.;
- 12V START;
- THERMOSTAT APPLIANCE REGULATOR;
- SAFETY SHUT-OFFVALVE;
- WALL MOUNT BRACKET AND VENT HOOD ASSEMBLY.

ARCHITECTURAL SCHEDULES

WALL (EXTERIOR)	TAN	QC-8315
WALL (INTERIOR)	WHITE ALUMINUM	
ROOF (EXTERIOR)	METRO BROWN	QC-8228
ROOF (INTERIOR)	WHITE ALUMINUM	
WALL FLASHINGS (EXTERIOR)	METRO BROWN	QC-8228
WALL FLASHINGS (INTERIOR)	CAMBRIDGE WHITE	QC-8695
ROOF FLASHINGS (SIDE AND FRONT)	METRO BROWN	QC-8228
ICE RAKES	STONE GREY	QC-8305
EAVESTROUGH	METRO BROWN	QC-8228
DOWNSPOUTS	METRO BROWN	QC-8228
DOOR FRAME TAN	METRO BROWN	QC-8228
DOOR SLAB	TAN	QC-8315
CANOPY	METRO BROWN	QC-8228

AS BUILT

MASTER COPY

Straight-Up Metal Buildings Ltd.

APPROVED

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01-34-065-03 W6M

0.43 kPa

2.2 kPa

WORK MA	WORK MAY PROCEED SUBJECT TO									
INCORPO	RATION OF CHANGES	INDICATED.								
CORRECT	AND RESUBMIT.									
WORK MAY <u>NOT</u> PROCEED.										
FOR INFORMATION ONLY.										
SUBMIT W	VITH FINAL DOCUME	NTATION. L								
AS-BUILT	REQUIRED									
DEPT SIGN DATE										
PROJECT CL Jul 7, 2025										
MECH	RA	27-Jun-2025								
PROCESS										
E&I										
CSA										
PIPING										
DC	OC									
CLIENT										

BLUESTAR ENGINEERING LTD VENDOR APPROVAL

ACCEPTED. WORK MAY PROCEED. SUBMIT

BLUESTAR REF: 236625

REVISE & RESUBMIT.

WITH FINAL DOCUMENTATION

0.1 kPa Sa(0.2, X) 0.269 Sa(0.5, X)0.238 Sa(1.0, X) 0.136 Sa(2.0, X) 0.0743 Sa(5.0,X) 0.042 Sa(10.0,X) 0.026

DESIGN DATA

AB

LOCATION

LSD

Q-1/50

Ss

BUILDING WEIGHT:

APPROX. 1,633 kgs

TRIPLE SSS

FLARE KNOCKOUT DRUM BUILDING

KARR MULTI WELL OIL BATTERY

ARCHITECTURAL - FLOOR PLAN & SECTION

25-8852-BLD-1 OA


CLIENT/VENDOR


BY DATE
MO 05 MAY/25
JV ... MAY/25 DESIGNED REVIEWED

... MAY/25 CONTRACT No. PROJECT No. Y24-110224

ENGINEERING RECORD

SCALE DRAWING NUMBER

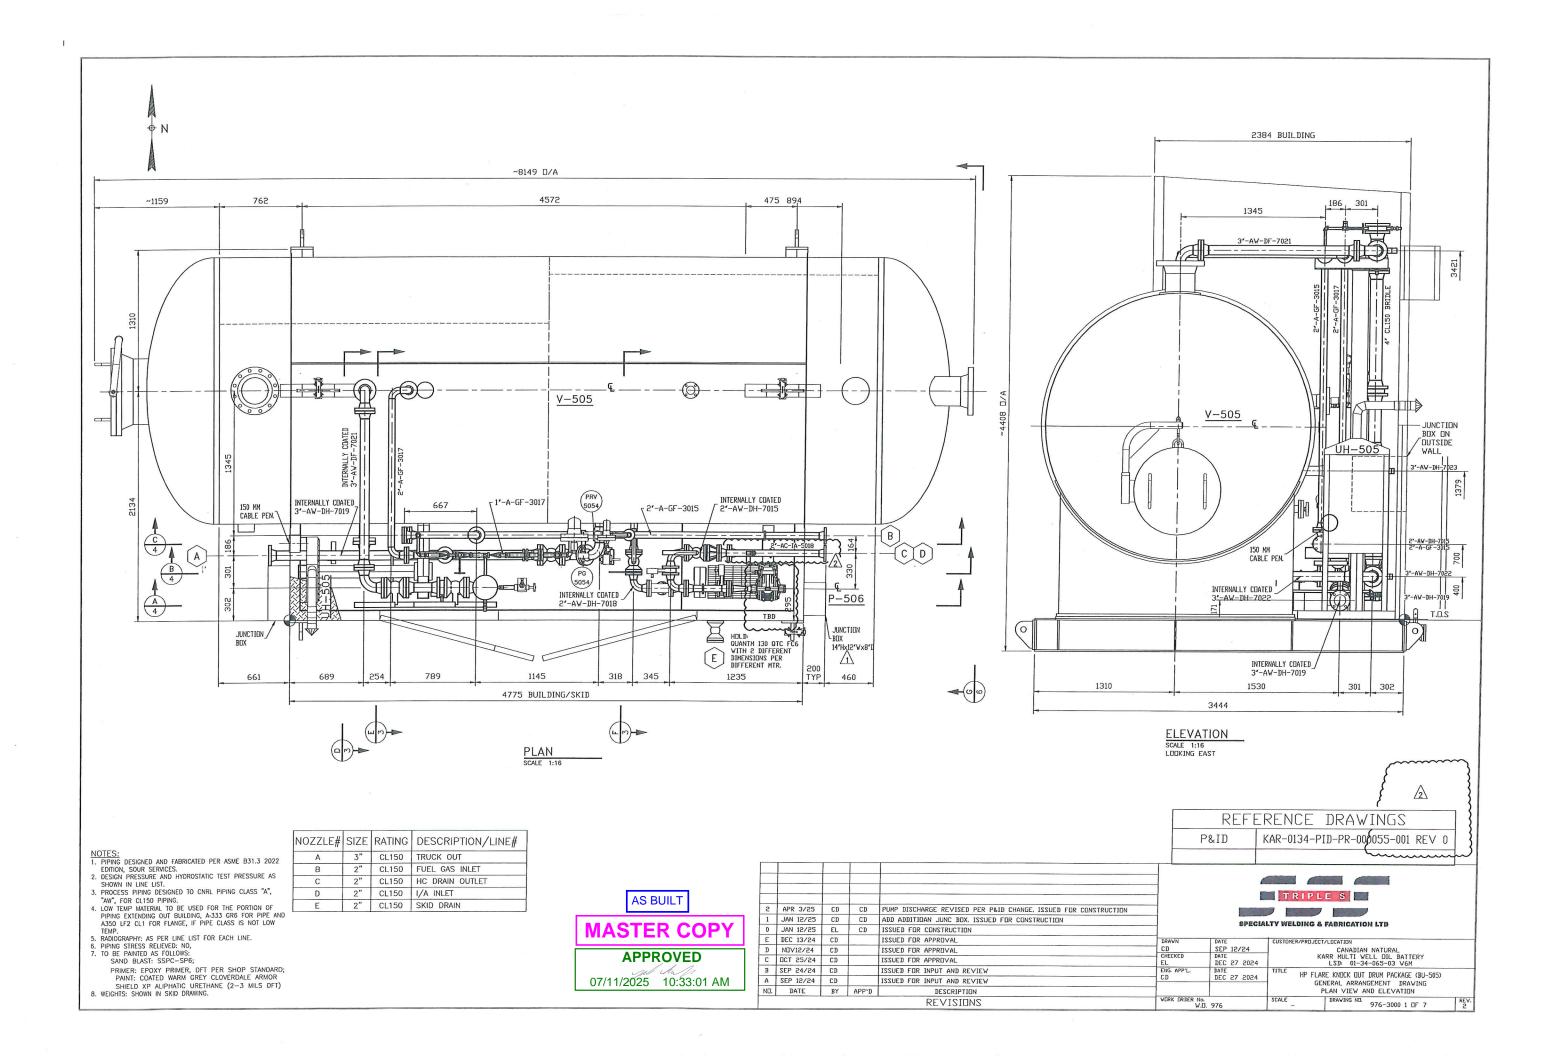

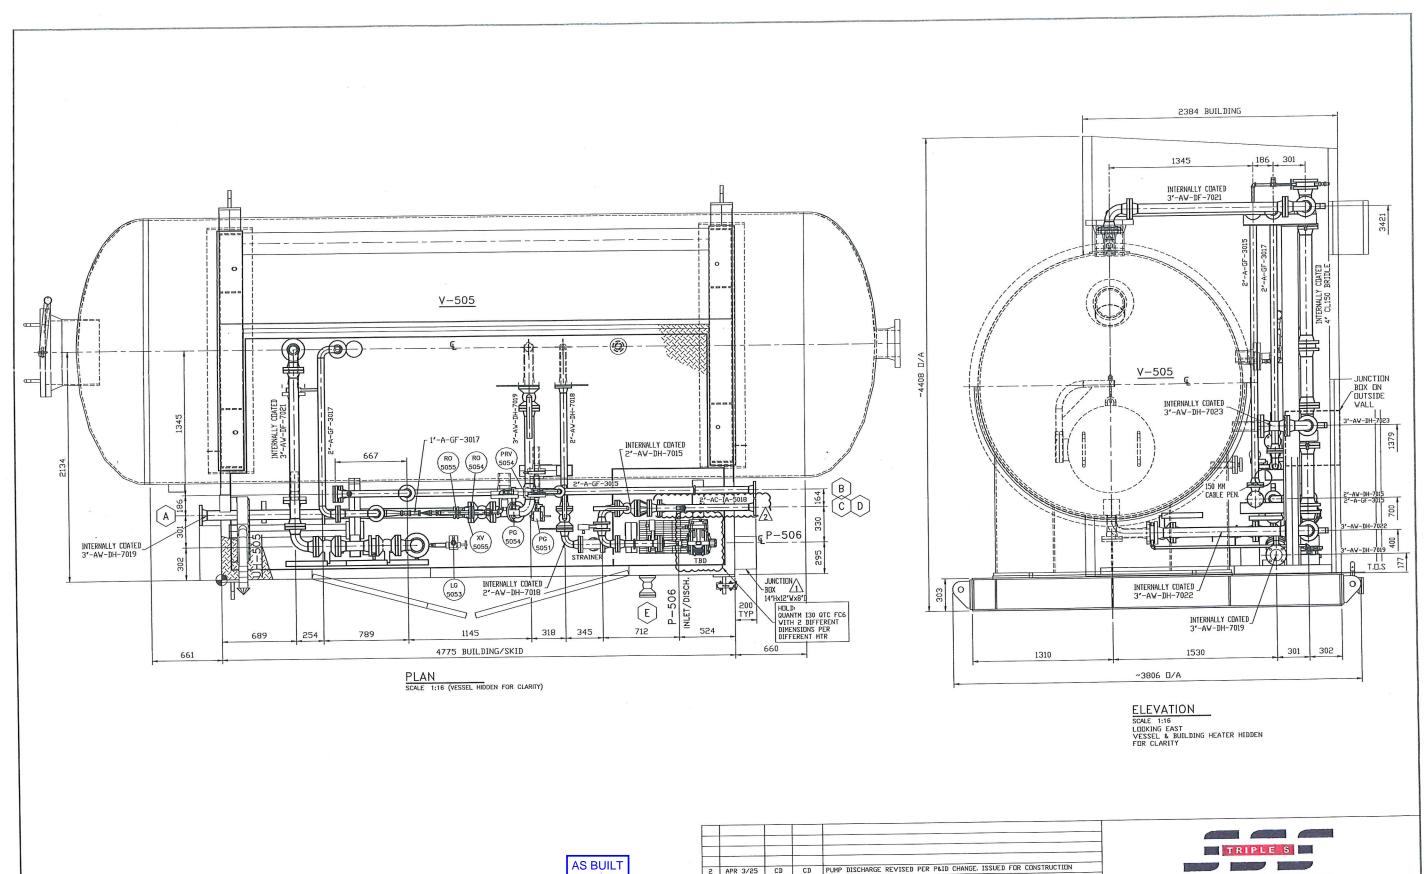



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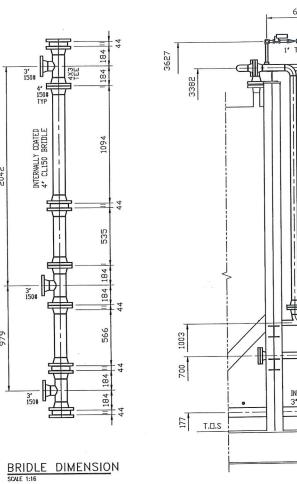
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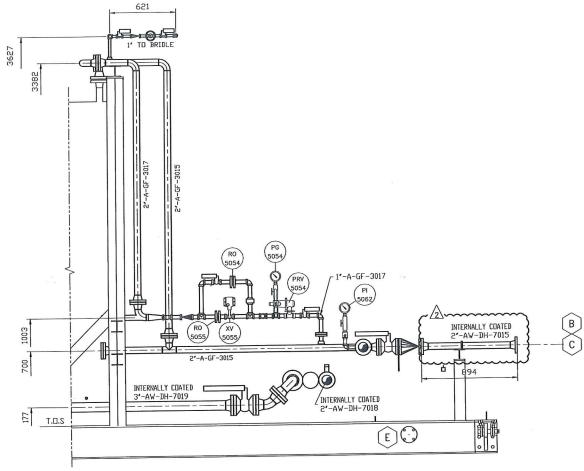
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2	APR 3/25 JAN 12/25	CD	CD	PUMP DISCHARGE REVISED PER PUID CHANGE. ISSUED FOR CONSTRUCTION ADD ADDITION JUNC BOX, ISSUED FOR CONSTRUCTION		SPECIAL	TY WELDING &	FABRICATION LTD
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D	N0V12/24	CD		ISSUED FOR APPROVAL ISSUED FOR APPROVAL	CHECKED	DATE DEC 27 2024	KA	RR MULTI WELL DIL BATTERY LSD: 01-34-065-03 V6M
В	DCT 25/24 SEP 24/24	CD		ISSUED FOR INPUT AND REVIEW	ENG. APP'L.	DATE DEC 27 2024	TITLE HP FLAR	E KNOCK OUT DRUM PACKAGE (BU-505) BERAL ARRANGEMENT DRAWING
Α	SEP 12/24	CD		ISSUED FOR INPUT AND REVIEW			PLAN VIE	W AND ELEVATION (VESSEL HIDDEN)
NO.	DATE	BY	APP'D	DESCRIPTION REVISIONS	VORK ORDER No. W.D.	976	SCALE _	DRAWING NO. 976-3000 2 DF 7







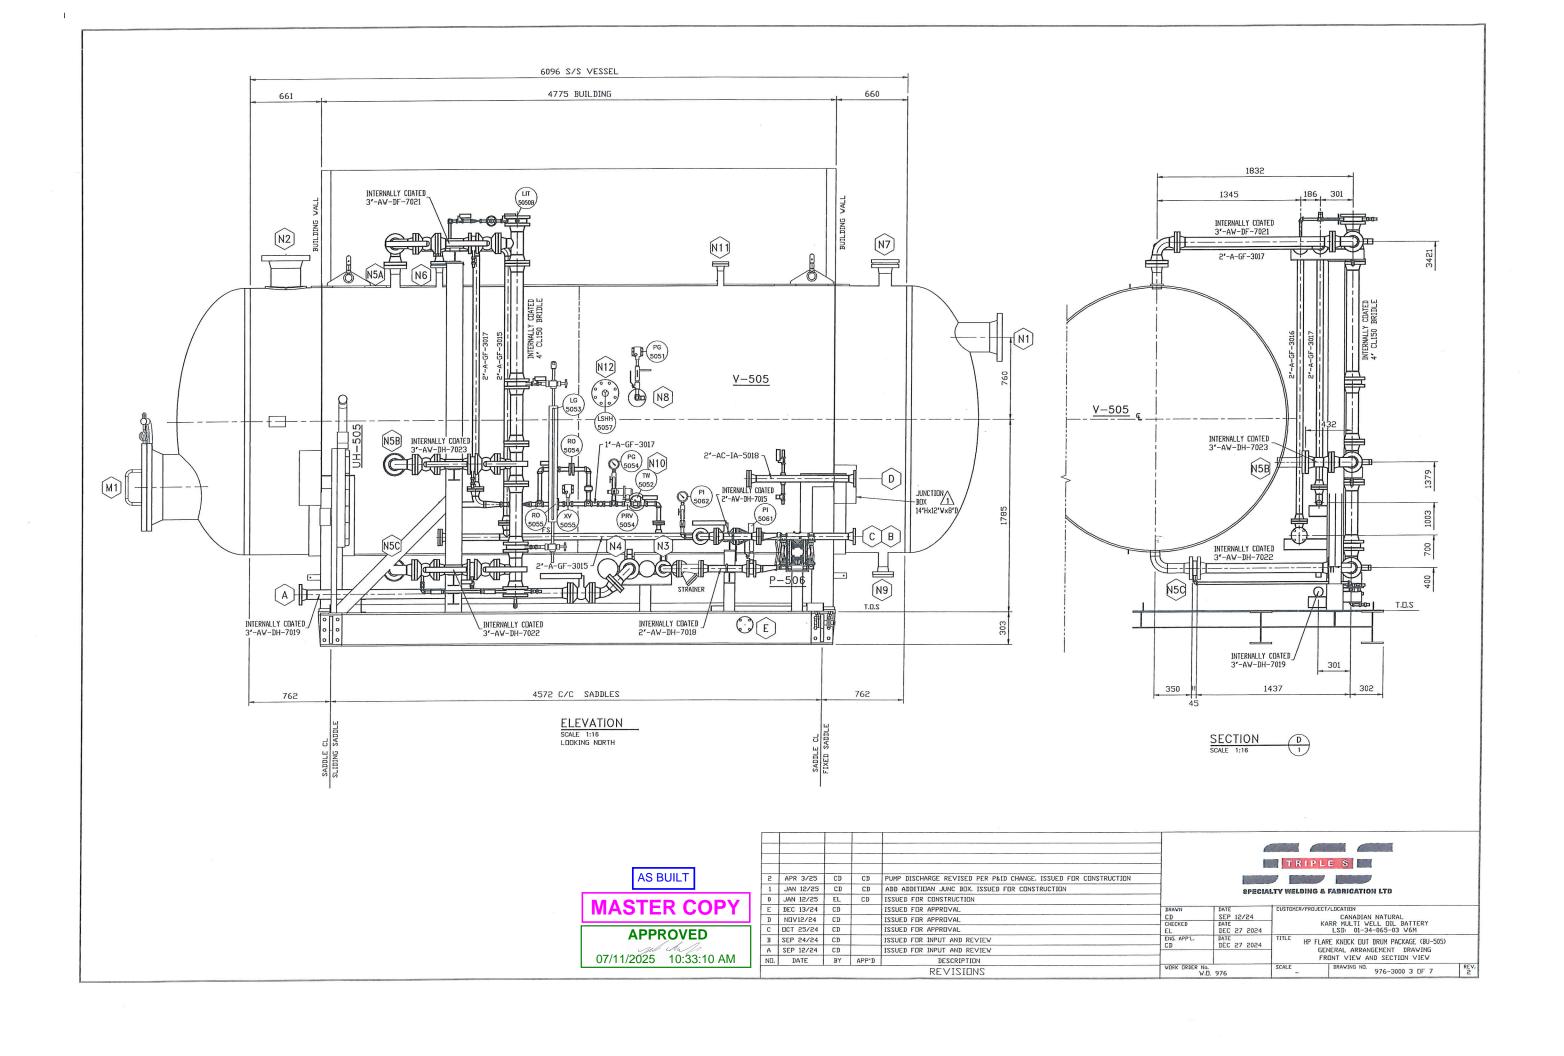

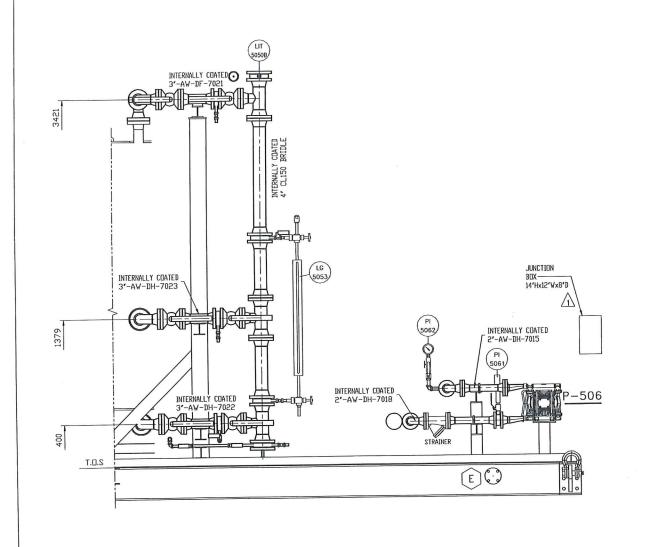ELEVATION A

ELEVATION B
SCALE 1:16


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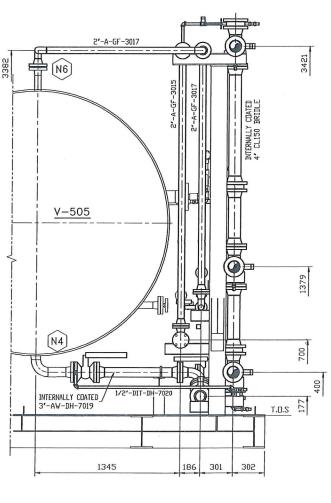
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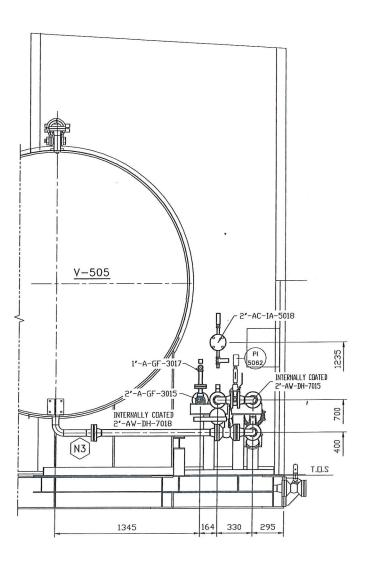
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ELEVATION C
SCALE 1:16 1

SECTION E

SECTION F


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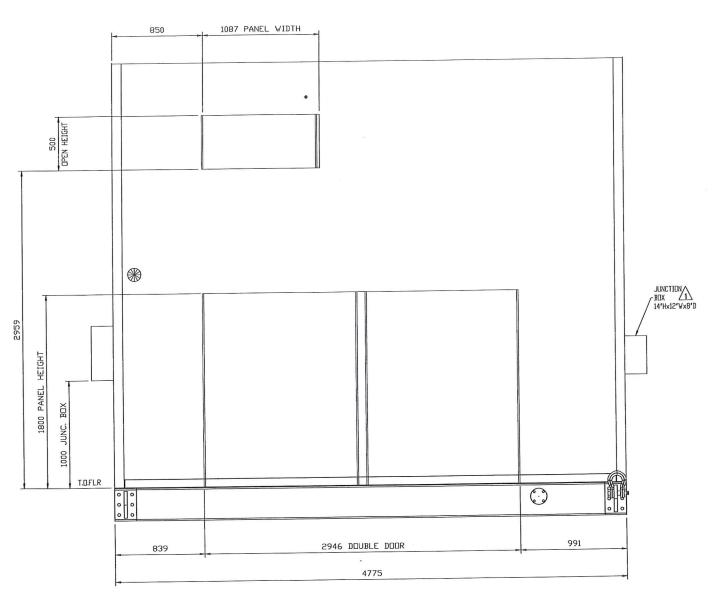
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FRONT DOOR PANEL LOCATION SCALE 1:16

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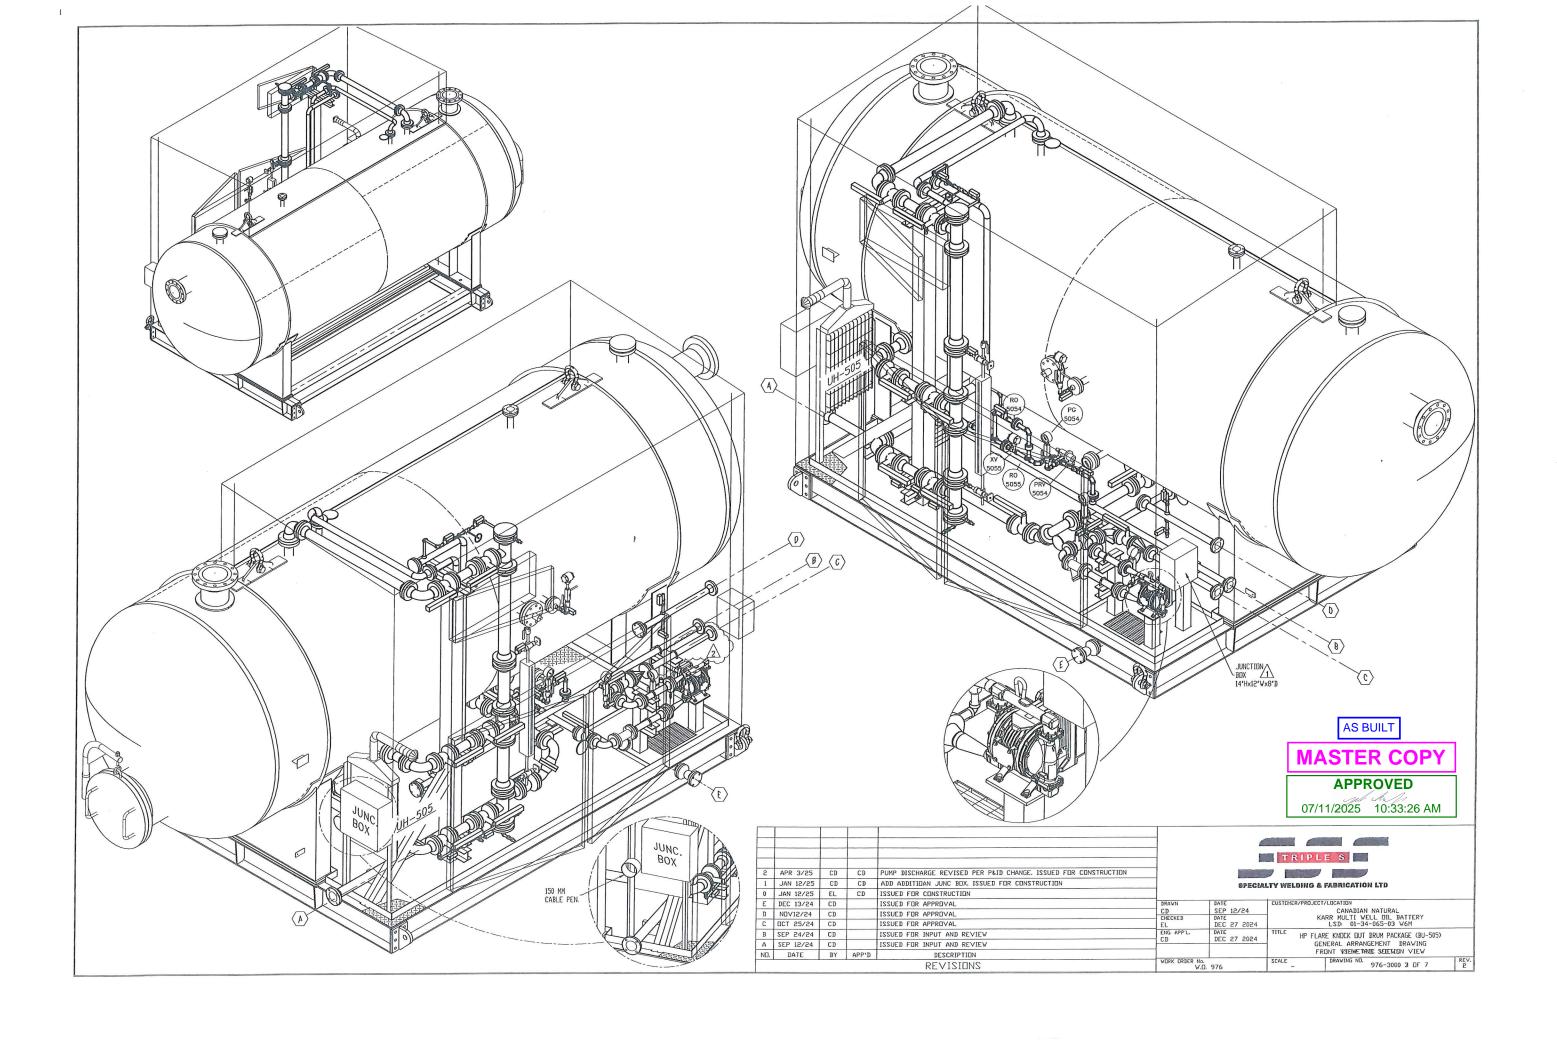
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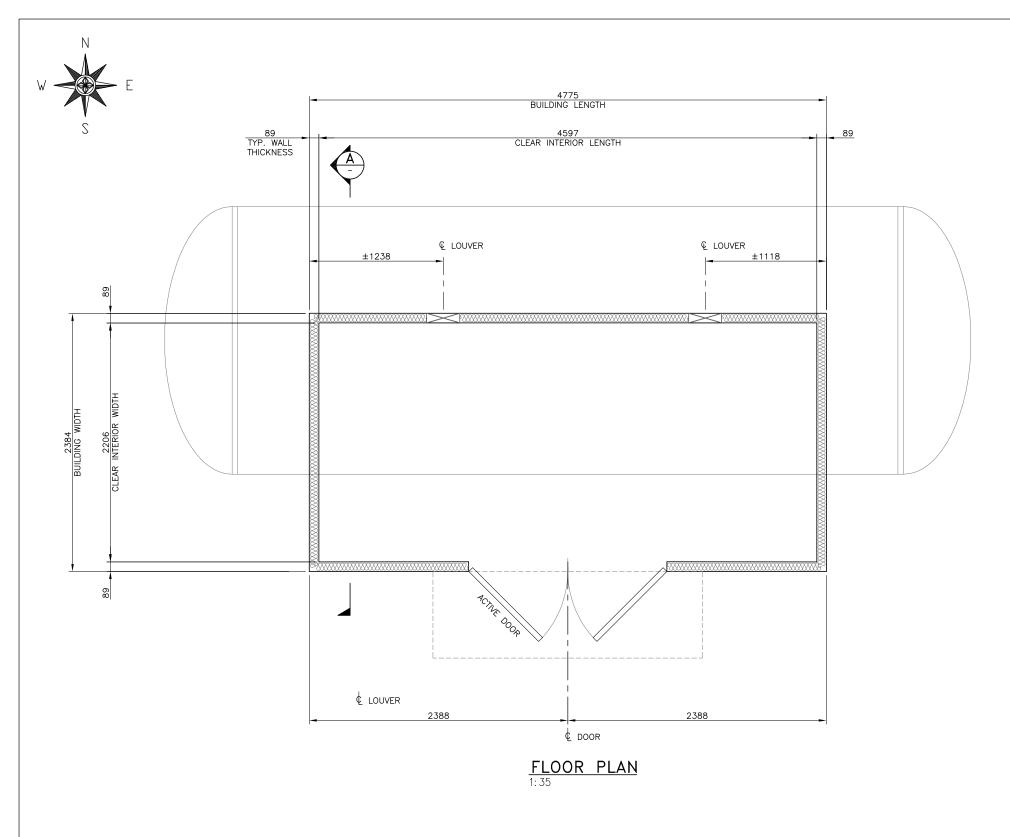
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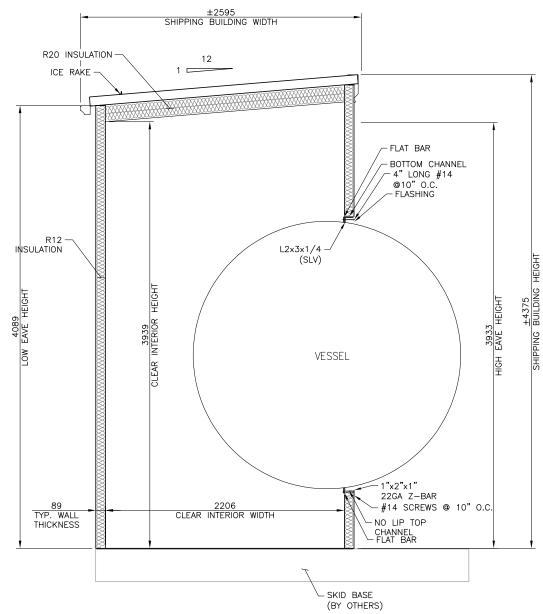
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| DATE | | CUSTOMER/PROJECT/LDCATION | CANADIAN NATURAL | CANADIAN NATURAL | KARR MULTI VELL OIL BATTERY | LSD: 01-34-065-03 V6M | DATE | DEC 27 2024 | | TITLE | HP FLARE KNOCK DUT DRUM PACKAGE (BU-505) | GENERAL ARRANGEMENT DRAVING | FRONT VSEQTIND VSEQTIND VSEQTIND VSEQTIND VSEQTIND | PROMISE | PROMISE

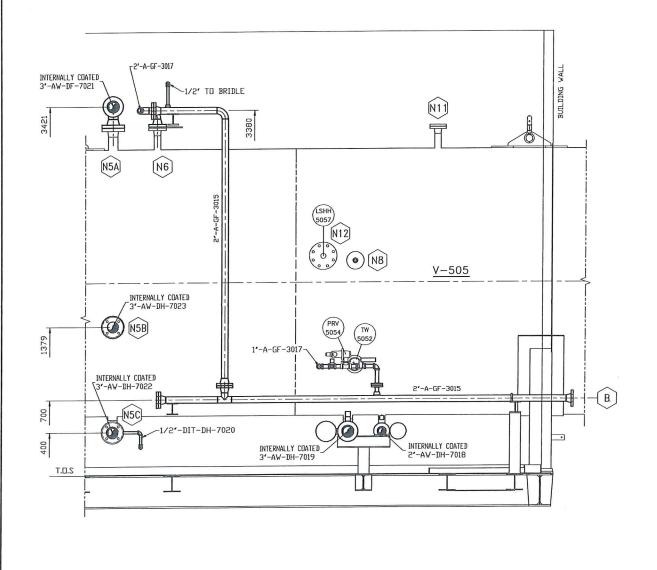





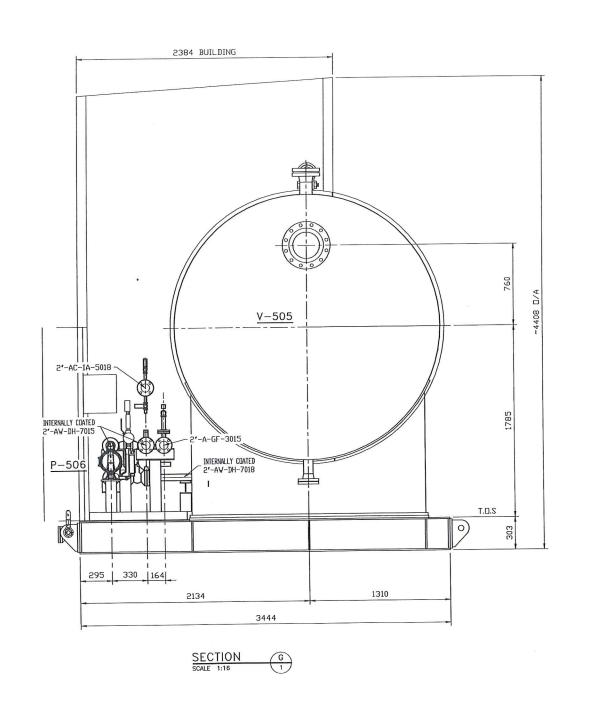


SECTION 1:35

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23 JUN/25 RE-ISSUED FOR APPROVAL	AG JV MF CORSO	STRAIGHT-UP METAL BUILDINGS LTD.		4 A h	DRAWN	MO 05 MAY/25	FLARE KNOCKOUT DRU	M DIIII DINC
08 JUL/25 ISSUED FOR CONSTRUCTION	MF JV MF	Mer Ting		AIPIN	CHECKED	JV MAY/25		
06 AUG/25 REVISION	MF JV MF (2)	RM SIGNATURE:		AAIIIMT.	DESIGNED	MF MAY/25	KARR MULTI WELL OIL	_ BATTERY
06 NOV/25 AS BUILT	AR JV MF (6)	RM APEGA ID #: ID# 96210			REVIEWED			DIANI 0- CECTION
		DATE: 2025-11-07		AUPINIONIA	P.O.	5895	ARCHITECTURAL — FLOOR F	PLAN & SECTION
		PERMIT NUMBER: P012663		STREET, STITL STITLAS LINE			SCALE DRAWING NUMBER	VDRL RE
	Structural Review Only ID# 96210	The Association of Professional Engineers and		METAL RUILDINGS LTD.	CONTRACT No.	Y24-110224	0E 00E0 DLD 0	
	2025-11-07	Geoscientists of Alberta (APEGA)		HIPTAN DAIRDINGS FLOI	PROJECT No.	25-8852	25-8852-BLD-2	

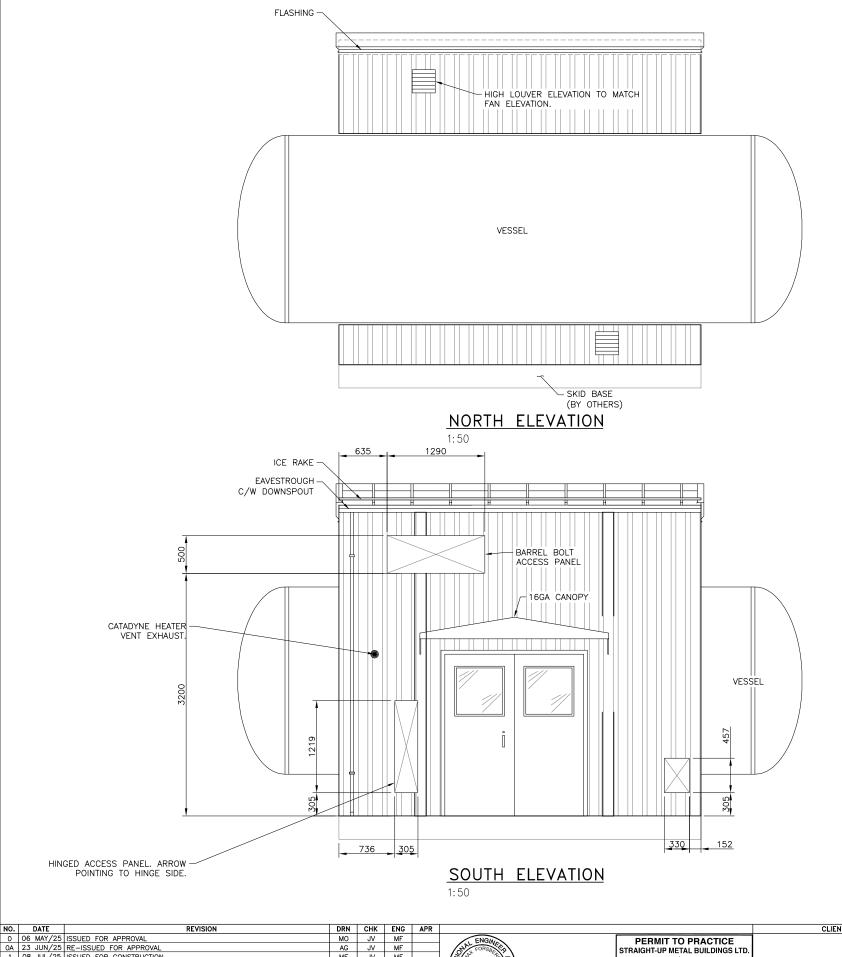

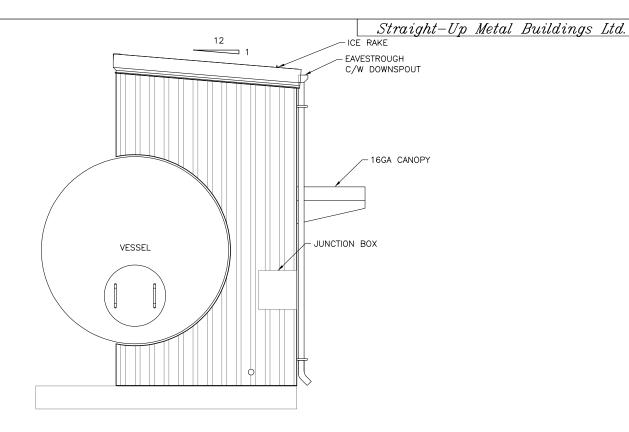


EAST ELEVATION

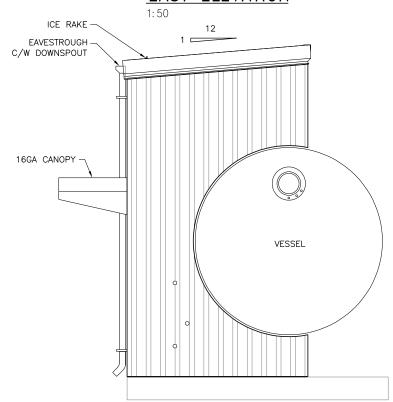


WEST ELEVATION

1:50


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OA 23 JUN/25 RE-ISSUED FOR APPROVAL	AG JV MF FORSALED	STRAIGHT-UP METAL BUILDINGS LTD.		DRAWN	MO 05 MAY/25	FLARE KNOCKOUT DRUM	DI III DINC	
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1A 06 AUG/25 REVISION	MF JV MF (H)	RM SIGNATURE:	AAIIIMT.	DESIGNED	MF MAY/25] KARR MULTI WELL OIL E	BATTERY	
1B 10 SEP/25 REVISION	MF JV MF (5)	RM APEGA ID #: ID# 96210		REVIEWED		ARCHITECTURAL — ELEV	ATIONIC	
2 06 NOV/25 AS BUILT	AR JV MF V PEEP	DATE: 2025-11-07	auriliviani 2	P.0.	. 5895	ARCHITECTURAL - ELEV	AHUNS	
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	Structural Review Only ID# 96210	The Association of Professional Engineers and	METAL RUIL DINGS LTD.	CONTRACT No.	Y24-110224	0E 00E0 DLD 7		2
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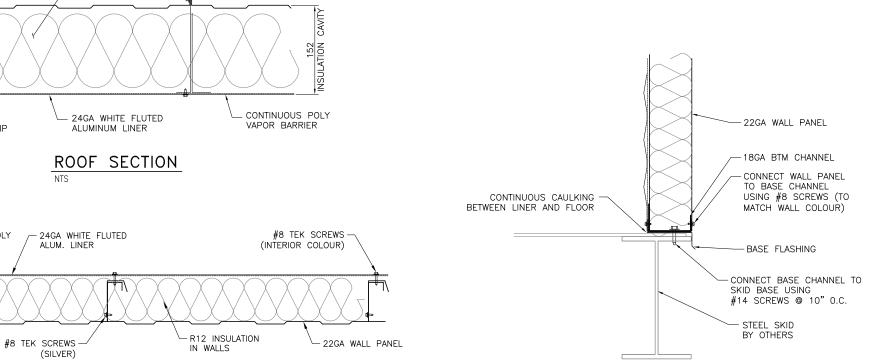
WALL ROOF CONNECTION DETAIL

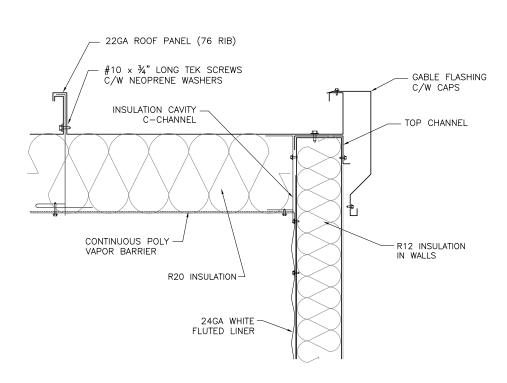

TYPICAL FRAMED OPENING

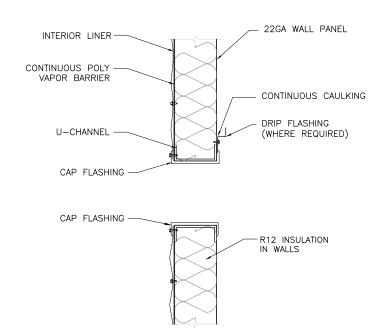

WALL SECTION AT LOW EAVE

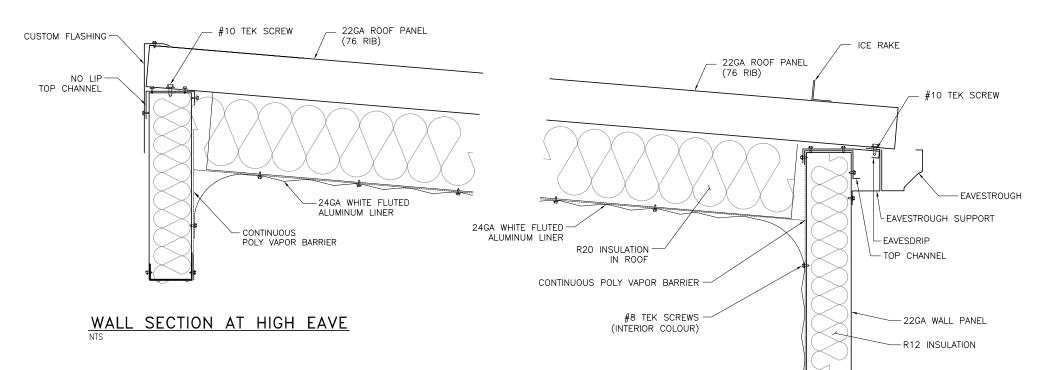

WALL SECTION

R20 INSULATION IN ROOF

-22GA ROOF PANEL (76 RIB)

18GA CUSTOM

INSULATION CLIP


CONTINUOUS POLY


VAPOR BARRIER

#10 x ¾" LONG TEK SCREWS C/W NEOPRENE WASHERS

WALL	10	BASE	SEC	HON
NTS				

NO.	DATE REVISION	DRN	СНК	ENG	APR		CLIENT/VENDOR	CONSULTANT LOGO	ENGINEERING	RECORD		TDIDLE CCC		
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						DATE: 2025-11-07 DEDMIT NI IMPED: DO12662		AUPINIMIA	P.O.	5895		ARCHITECTURAL — DE	LIAILS	
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						Structural Review Cety ID# 08/210 The Association of Professional Engineers and		METAL RUIL DINGS LTD	CONTRACT No. Y	24-110224		0E 00E0 DLD 4		
						2025-11-07 Geoscientists of Alberta (APEGA)		INPINE AAIFAILAA FIAI	PROJECT No.	25-8852		25-8852-BLD-4		4

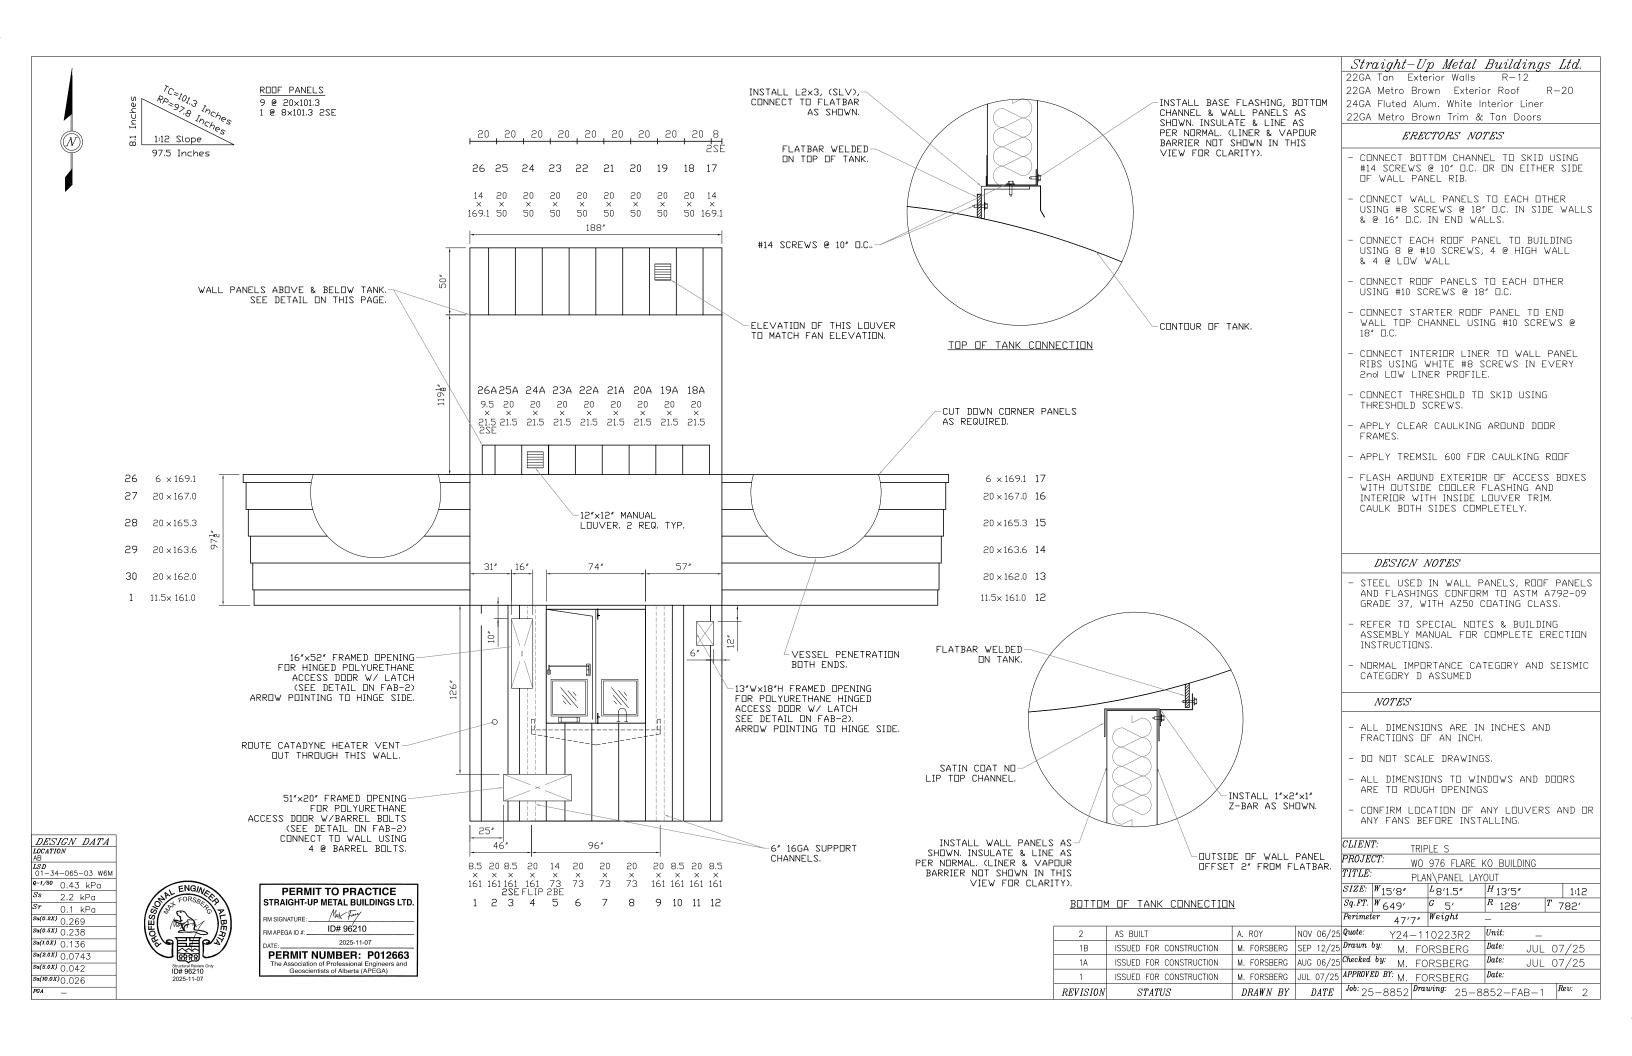

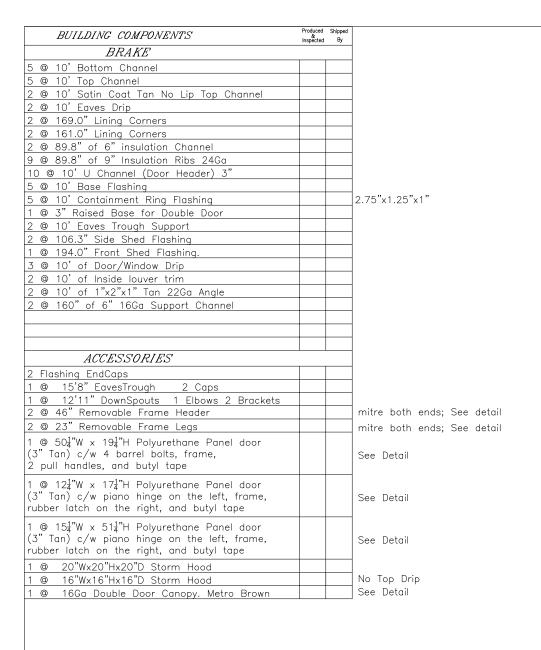

DOORS	
# TP SW G P L C A B WS S T H FM	
1 DD R 2 1 - 1 1 2 2 2 2 2 1	
FABRICATION	
1 @ 15'8" Ice Rake	
1 @ 15'7" 2"x3"x3/16" Angle. Paint Warm Grey	
MISC	
2 Roll of 6mil Certified Poly Vapour Barrier	
31 @ 3x10 Fluted Alum. White Liner	
5 @ Bags of R12 Insulation (133)	
2 @ Bags of R20 Insulation (73)	
2000 @ 1/2" long silver #8 Screws	
2000 @ 1/2" long silver #8 Screws 2000 @ 1/2" long white #8 Screws	
1000 @ 1/2" long tan #8 Screws	
400 @ 3/4" long #10 Screws	
20 @ 1.25" long super #10 Screws	
150 @ 1.5" long #14 Screws	
12 @ Tubes of White Caulking	
12 @ Tubes of Gray Caulking	
3 @ Tubes of Clear Caulking	
12 @ Tubes of Tremsil600 Caulking	
5 @ Threshold screws	
1 Roll 1/2" Butyl Tape	
3 Rolls of Tuck Tape	
HVAC	
2 @ 12"x12" Manually Operable Louver c/w:	
Flange frame; Manual Wing Nut Controller; Screen	
and 22Ga Storm Hood.	
1 @ 24"x30" Catadyne Heater. (Supply Only)	

FULLY CAULK ALL
SEAMS AND JOINTS

FOAM TAPE


POLYURETHANE
ACCESS DOOR

16GA R4 Slab, 16GA Frame, Closure, Wlndow, Panic Hardware. Tan

ACCESS DOOR, HINGED or W/ BARREL BOLTS

> FOAM TAPE

- REMOVABLE FRAME

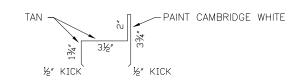

REMOVABLE FRAME (HEADER AND LEGS)

Straight-Up Metal Buildings Ltd.

22GA Tan Exterior Walls R-12

22GA Metro Brown Exterior Roof R-20

24GA Fluted Alum. White Interior Liner

22GA Metro Brown Trim & Tan Doors

DOOR LEGEND:
TP=TYPE (SD=SINGLE DOOR DD=DOUBLE DOOR)
SW=SWING (L=LEFT R=RIGHT)
G=GLASS
P=PANIC HARDWARE

A=AUTO CLOSURE B=BARREL BOLTS WS=WEATHERSTRIPPING S=SWEEPS T=THRESHOLD

T=THRESHOLD
H=HINGES
FM=FRAME

C=CHECK CHAIN

L=LOCKSET

96"

978"

12GA GUSSETS, BOTH ENDS.

16GA DOUBLE DOOR CANOPY (36" PROJECTION)



PERMIT TO PRACTICE
STRAIGHT-UP METAL BUILDINGS LTD.

RM SIGNATURE: ID# 96210

DATE: 2025-11-07

PERMIT NUMBER: P012663

The Association of Professional Engineers and Geoscientists of Alberta (APEGA)

 CLIENT:
 TRIPLE S

 PROJECT:
 WO 976 FLARE KO BUILDING

 TITLE:
 CUTLIST

 SIZE:
 W15'8"
 L8'1.5"
 H 13'5"
 1:12

 Sq.FT:
 W 649'
 G 5'
 R 128'
 T 782'

 Perimeter
 47'7"
 Weight
 —

NOV 06/25 Quote: Y24-110223R2 *Unit*: AS BUILT M. FORSBERG SEP 12/25 Drawn by: M. FORSBERG Date: 1B ISSUED FOR CONSTRUCTION JUL 07/25 M. FORSBERG AUG 06/25 Checked by: M. FORSBERG Date: ISSUED FOR CONSTRUCTION JUL 07/25 M. FORSBERG JUL 07/25 APPROVED BY: M. FORSBERG ISSUED FOR CONSTRUCTION DATE | Job. 25-8852 | Drawing: 25-8852-FAB-2 | Rev. 2 DRAWN BY REVISION STATUS

GENERAL NOTES FOR BUILDING:

GENERAL NOTES:

- 1. BUILDING PACKAGE CONFORMS TO:


 NATIONAL BUILDING CODE 2023-ALBERTA EDITION
- 2. GROUP F DIVISION 3 OCCUPANCY CATEGORY AS PER NATIONAL BUILDING CODE CANADA 2020, TABLE 3.1.2.1

BUILDING IMPORTANCE CATEGORY - NORMAL

BUILDING COMPONENTS:

- <u>EXTERIOR WALL AND ROOF PANELS:</u>
22GA PREPAINTED GALVALUME PANELS CONFORMING TO ASTM A792-09, WITH COATING CONFORMING TO AZ50.

SELF-FRAMING PANEL DIMENSIONS:

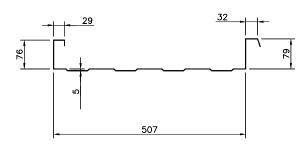

BUILDING NOTES:

- 1. MULTI OIL WELL BATTERY BUILDING SHALL BE A GABLE STYLE SELF—FRAMING BUILDING, ERECTED ON A STEEL SKID IN OUR YARD.
- 2. WALL TO CONSIST OF:
 - 22GA SELF-FRAMING WALL PANELS;
 - R12 (76mm) INSULATION;
 - CONTINUOUS 6MIL CERTIFIED POLY VAPOR BARRIER;
 - 24GA WHITE FLUTED ALUMINUM LINER.
- 3. ROOF TO CONSIST OF:
 - 22GA SELF-FRAMING ROOF PANELS;
 - 24GA INSULATION CLIPS 9" DEEP 24GA;
 - R20 (152mm) INSULATION;
 - CONTINUOUS 6MIL CERTIFIED POLY VAPOR BARRIER;
 - 24GA WHITE FLUTED ALUMINUM LINER.
- 4. 1 @ FULL LENGTH ANGLE ICE RAKES
- 1 @ FULL LENGTH EAVES TROUGH C/W GUTTER, DOWNSPOUT AND ELBOW.
- 6. 1 @ 16GA 1829mm W x 2,134mm H R4 INSULATED HOLLOW CORE DOUBLE DOOR C/W:
 - 16GA DOUBLE DOOR FRAME;
 - HYDRAULIC CLOSER;
 - CHECK CHAIN;
 - TWO (2) 610mm W x 610mm H IWG WINDOWS;
 - BARREL BOLTS;
 - DOREX PANIC HARDWARE;
 - WEATHER STRIPPING;
 - SWEEPS;
 - THRESHOLD;
 - 16GA DOUBLE DOOR CANOPY W/ TWO (2) 16GA VERTICAL SUPPORT CHANNELS.

7. 1 @ 1087mm W x 500mm H ACCESS DOOR

B. HVAC

(REFER TO DATA SHEETS FOR FULL SPECS; ANY DISCREPANCY BETWEEN THESE DRAWINGS AND DATA SHEETS, THE DATA SHEETS SHALL BE ASSUMED CORRECT)

- 2 @ 12"W x 12"H MANUALLY OPERABLE LOUVER C/W:
- FLANGE FRAME:
- MANUAL WING NUT CONTROLLER;
- BIRD SCREEN;
- 22GA STORM HOOD.
- 1 @ SUPPLY ONLY CATADYNE WX24x30 CATALYTIC HEATER C/W:
- 20,000 BTUH;
- NATURAL GAS CONFIG.;
- 12V START;
- THERMOSTAT APPLIANCE REGULATOR;
- SAFETY SHUT-OFFVALVE;
- WALL MOUNT BRACKET AND VENT HOOD ASSEMBLY.

ARCHITECTURAL SCHEDULES

WALL (EXTERIOR)	TAN	QC-8315	
WALL (INTERIOR)	WHITE ALUMINUM		
ROOF (EXTERIOR)	METRO BROWN	QC-8228	
ROOF (INTERIOR)	WHITE ALUMINUM		
WALL FLASHINGS (EXTERIOR)	METRO BROWN	QC-8228	
WALL FLASHINGS (INTERIOR)	CAMBRIDGE WHITE	QC-8695	
ROOF FLASHINGS (SIDE AND FRONT)	METRO BROWN	QC-8228	
ICE RAKES	METRO BROWN	QC-8305	
EAVESTROUGH	METRO BROWN	QC-8228	
DOWNSPOUTS	METRO BROWN	QC-8228	
DOOR FRAME	METRO BROWN	QC-8228	
DOOR SLAB	TAN	QC-8315	
CANOPY	METRO BROWN	QC-8228	

LOCATION	AB
LSD	01-34-065-03 W6M
Q-1/50	0.43 kPa
Ss	2.2 kPa
Sr	0.1 kPa
Sa(0.2,X)	0.269
Sa(0.5,X)	0.238
Sa(1.0,X)	0.136
Sa(2.0,X)	0.0743
Sa(5.0,X)	0.042
Sa(10.0,X)	0.026
PGA	_
DITIL DIVIO	WEIGHT

Straight-Up Metal Buildings Ltd.

BUILDING WEIGHT:

DESIGN DATA

APPROX. 1,633 kgs



	IT TO PRACTICE P METAL BUILDINGS LTD.
RM SIGNATURE: _ RM APEGA ID #: _	Mux Fuy ID# 96210
DATE:	2025-11-07
The Association	NUMBER: P012663 on of Professional Engineers and entists of Alberta (APEGA)

CLIENT/VENDOR

CONSULTANT LOGO

ENGIN	EERING RE	CORD	
	BY	DATE	
DRAWN	МО	05 MAY/25	
CHECKED	JV	MAY/25	
DESIGNED	MF	MAY/25	
REVIEWED			
P.0.		5895	
CONTRACT No.	Y24-	-110224	

TRIPLE SSS
FLARE KNOCKOUT DRUM BUILDING
KARR MULTI WELL OIL BATTERY
ARCHITECTURAL - FLOOR PLAN & SEC



Certificate of Design and Manufacturing Conformance with NBC, 2020

This Certificate is to affirm that all components of the steel building system described below, to be supplied by the Manufacturer, Straight-Up Metal Buildings Ltd., certified in accordance with CSA A660, have been or will be designed and fabricated in accordance with the following Standards to carry the loads and load combinations specified.

1. DESCRIPTION:					
Manufacturer's Name and Address	Straight-Up Metal buildings Ltd. 98 Carmek Blvd. Rocky View Co	unty, AB, T1X 1X1			
Manufacturer's Certificate No. under CSA A660	strai0				
Customer Order Number	Straight-Up job 25-8852				
Building Type and Size	2,384mm W x 4,775mm L x 3,734mm H Shed Si	tyle Building			
Intended Use and Occupancy	Group F division 3	Group F division 3			
Importance Category (NBC, Sentence 4.1.2.1.(3))	Normal				
Site Location	01-34-065-03 W6M				
Applicable Building Code	National Building Code 2023- Alberta Edition				
Builder's Name and Address	Straight-Up Metal buildings Ltd. 98 Carmek Blvd. Rocky View Co	unty, AB, T1X 1X1			
Owner's Name and Address	CNRL				
2. DESIGN STANDARDS		Engineer's Initials*			
National Building Code of Canada, 2020, Part 4: Stru	ictural Design	MF			
CAN/CSA-S16-19, Limit States Design of Steel Struct					
CAN/CSA-S136-16, North American Specification for	the Design of Cold-Formed Steel Structural Members				
Other (specify)	CSA A277 Dated	25-Jun-25			
3. MANUFACTURING STANDARDS		MF			
(A) Fabrication has been or will be in accordance w	ith CAN/CSA-S16 and CAN/CSA-S136, as applicable	, .			
	dance with CSA W59 and CAN/CSA-S136, as applicable				
	nce with CSA W47.1, for Division 1 or 2, and/or CSA W55.3, if				
applicable	thee with CSA W47.1, for Division 1 or 2, unique CSA W55.5, ii				
(D) Welders have been qualified in accordance with	n CSA W47.1				
(2) trouble real quantity and massive and					
4. PURLIN STABILITY		N/A			
Purlin braces are provided in accordance with CAN/	CSA-S136, Clause D3 and Appendix B, Clause D3.2.3. In particular, for	a standing seam roof			
	I support to both top and bottom purlin flange have been or will be pr				
	than 1 for spans up to 7m inclusive or less than 2 for spans greater th				
5. LOADS					
(A) Snow and Rain Load		MF			
1-in-50 year ground snow load, Ss,	2.2	(kPa)			
1-in-50 year associated rain load, Sr,		(kPa)			
Wind exposure factor, Cw,	1	· · ·			
Importance Factor, Is,	1				
Roof snow load, S,	1.86	(kPa)			

*Initial each true statement. Mark N/A if statement does not apply.

Drift load considered (NBC Sub-section 4.1.6.2.8) refer to drawing of specific building

Specified rain load (NBC, Article 4.1.6.4)

(mm)



Certificate of Design and Manufacturing Conformance with NBC, 2020

5. LOADS con't					Engineer's Initials*
B) Full and Partial Snow Load	andiacont chang of continue	ue purline			N/A
i) Applied on any one and any twoii) Applied on any one and any two			oof beams		
iii) Applied as described for the buil	ding geometry in NBC 2020	, Part 4.1.6.			
					145
C) Wind Load					<u>M</u> F
I-in-50 year r	eference velocity pressure _		0.43		(kPa)
	Importance Factor, Iw _		1		
D) Wind Load Application					MF
) Applied as per NBC, Part 4, Sub-	section 4.1.7				
i) Pressure coefficients as per NBC	2020 Part 4.1.7, Figures 4.1.	7.6-A - 4.1.7.6-H.			
iii) Building internal pressure Categ	ory <u>1</u> per NBC 202	20, Part 4.1.7, Table 4.1.7.7.			
E) Crane Loads (where applicable)					N/A
, , , ,	Туре		N/A	(top r	running)(under-running)(jib)
	Capacity		N/A	(tonnes)	
	Wheel Base		N/A	(m)	
Maximum	Static, vertical wheel load _		N/A	(kN)	
	Vertical impact factor		N/A	%	
Lateral Factor	N/A	<u>,</u> %	Lateral Wheel		
Longitudinal Factor	N/A %	6	Maximum Longite	udinai Load	N/A (kN/side)
F) Mezzanine Live Load		N/A		(kPa)	N/A
					MF
G) Seismic Load:					/*//
H) Other Live Loads (specify)					MF
	1.0 KF	Pa live load on roof			_
) Dead Loads					MF
ead Load of building components i	s incorporated in the design				·
Collat	teral load (mechanical, electi	rical, ceiling, sprinklers, etc.)			
Mezzanine N/A	(kPa)	0	other (Specify)	0.5 (kPa)	
					M
Load Combinations Partial in accordance with NRC Rev	rt A Costian A 1				MF
pplied in accordance with NBC, Par .25D+1.5S, 0.9D+1.4W	t 4, Section 4.1.				
. GENERAL REVIEW DURING CONS	TRUCTION				
The Manufactu		ings Ltd., does not provide gel true statement. Mark N/A if	_		purposes.
. CERTIFICATION BY ENGINEER		Mark Ny A I		··· / ·	
Max Forsberg	2.1	Professional Engineer register	ed or licensed to practice	in the Province or Tor	ritory of
lberta		that I have reviewed the des			
ertify that the foregoing statement			.g 2.10a.iaiaiaiaiainig pi	11100 TO. LITE SECONDUM	
NAME	Max Forsberg		SIGNAT	TLIRE 4	ENGIA
			JIGNAI		FORESTA
AFFILIATION	P.Eng Straight-Up Metal Buildin	ngs Ltd	Γ	DATE /	2+ 101/08/2/2/
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Professional Seal				(世(MAN IS
		PERMIT TO PE		<u> હ</u> ੋ	
		STRAIGHT-UP METAL E		1/2/	
		RM SIGNATURE:	/		
		RM APEGA ID #: ID# 96			ID# 96210
UQMSExhibit 12.3.6		PERMIT NUMBER	-06-24 D: D012663		2025-06-24
		· PERMII MUMBER	1: PUIZODJ I		DACE 2

Section 12, Rev. 0

The Association of Professional Engineers and Geoscientists of Alberta (APEGA)